## THERAPEUTIC SPLASH PAD

FOR

ELLISVILLE STATE SCHOOL

# CONTRACT "A" SWIMMING POOL DEMOLITION AND SITE WORK

ELLISVILLE, MISSISSIPPI

CNC PROJECT NO: ESS-102-18-A
BID ISSUE
DECEMBER 12, 2019






CHAS. N. CLARK ASSOC., LTD.

Consulting Engineers


714 Hillcrest Dr. • Laurel, MS 39440
601-649-5900 • (Fax) 601-649-5963


### DRAWING INDEX


- 0.0 TITLE SHEET
- 1.0 EXISTING SITE & DEMOLITION PLAN
- 2.0 SITE PLAN: PHASE I
- 2.1 SITE PLAN: PHASE II
- 3.0 DETAILS
- 3.1 DETAILS
- 4.0 PERGOLA PLANS

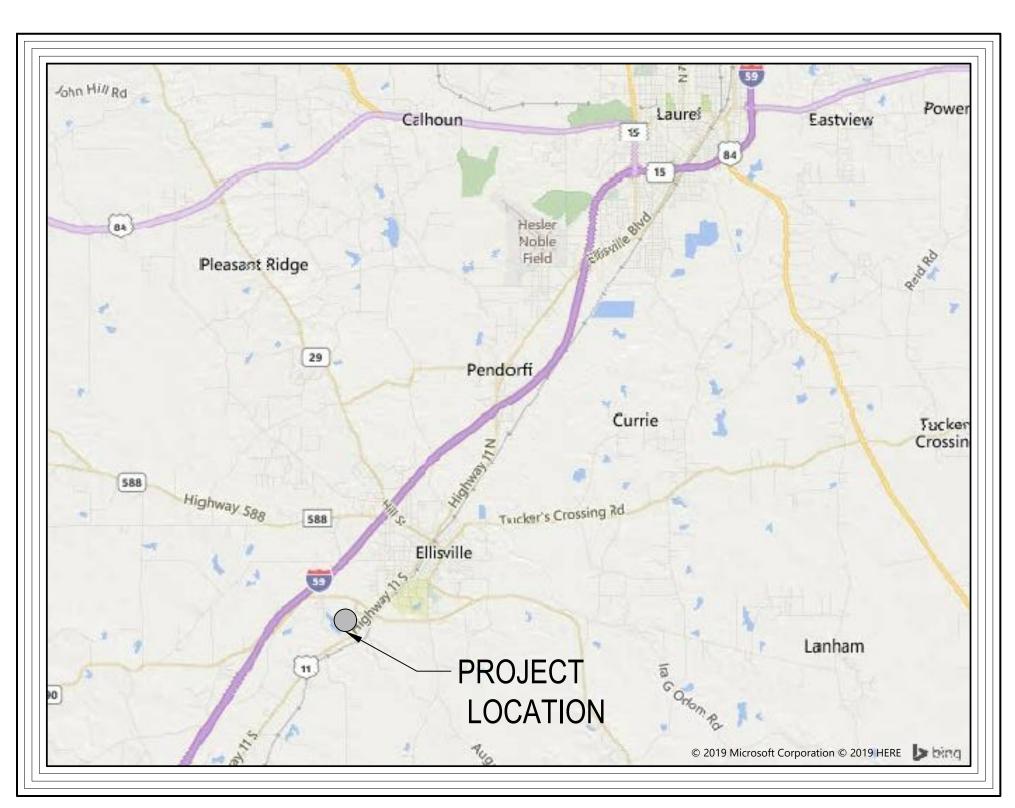


VICINITY MAP

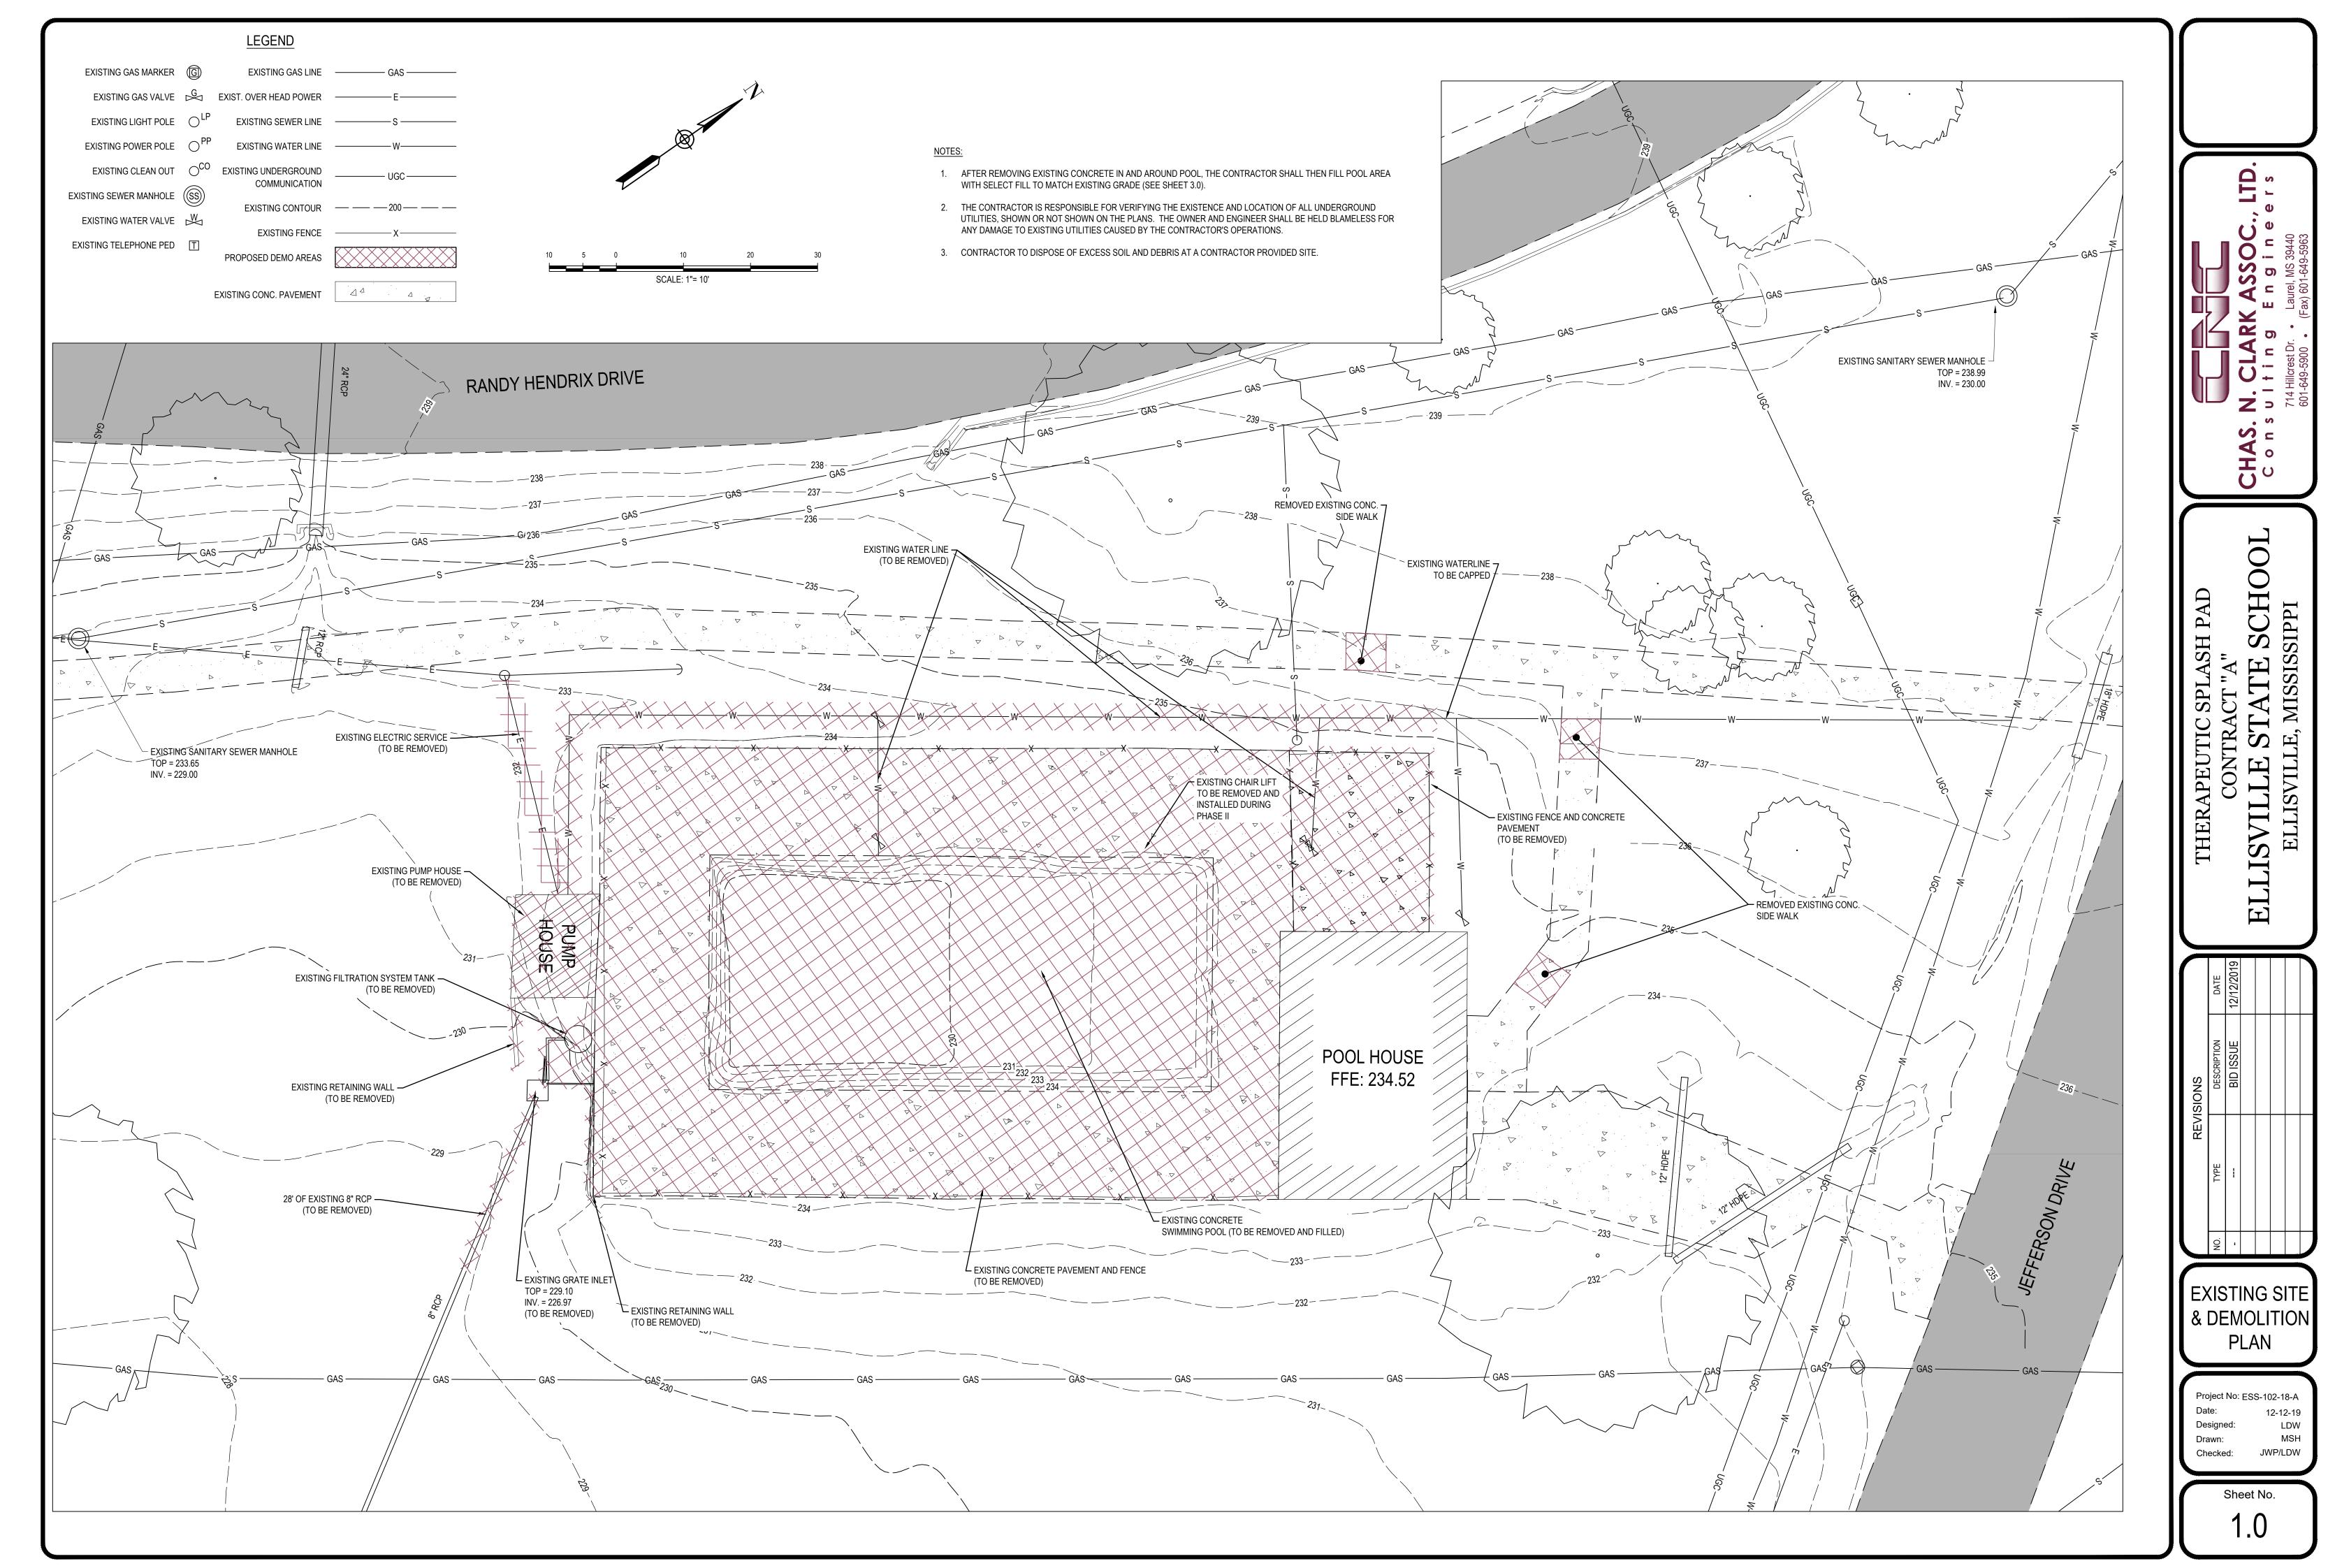

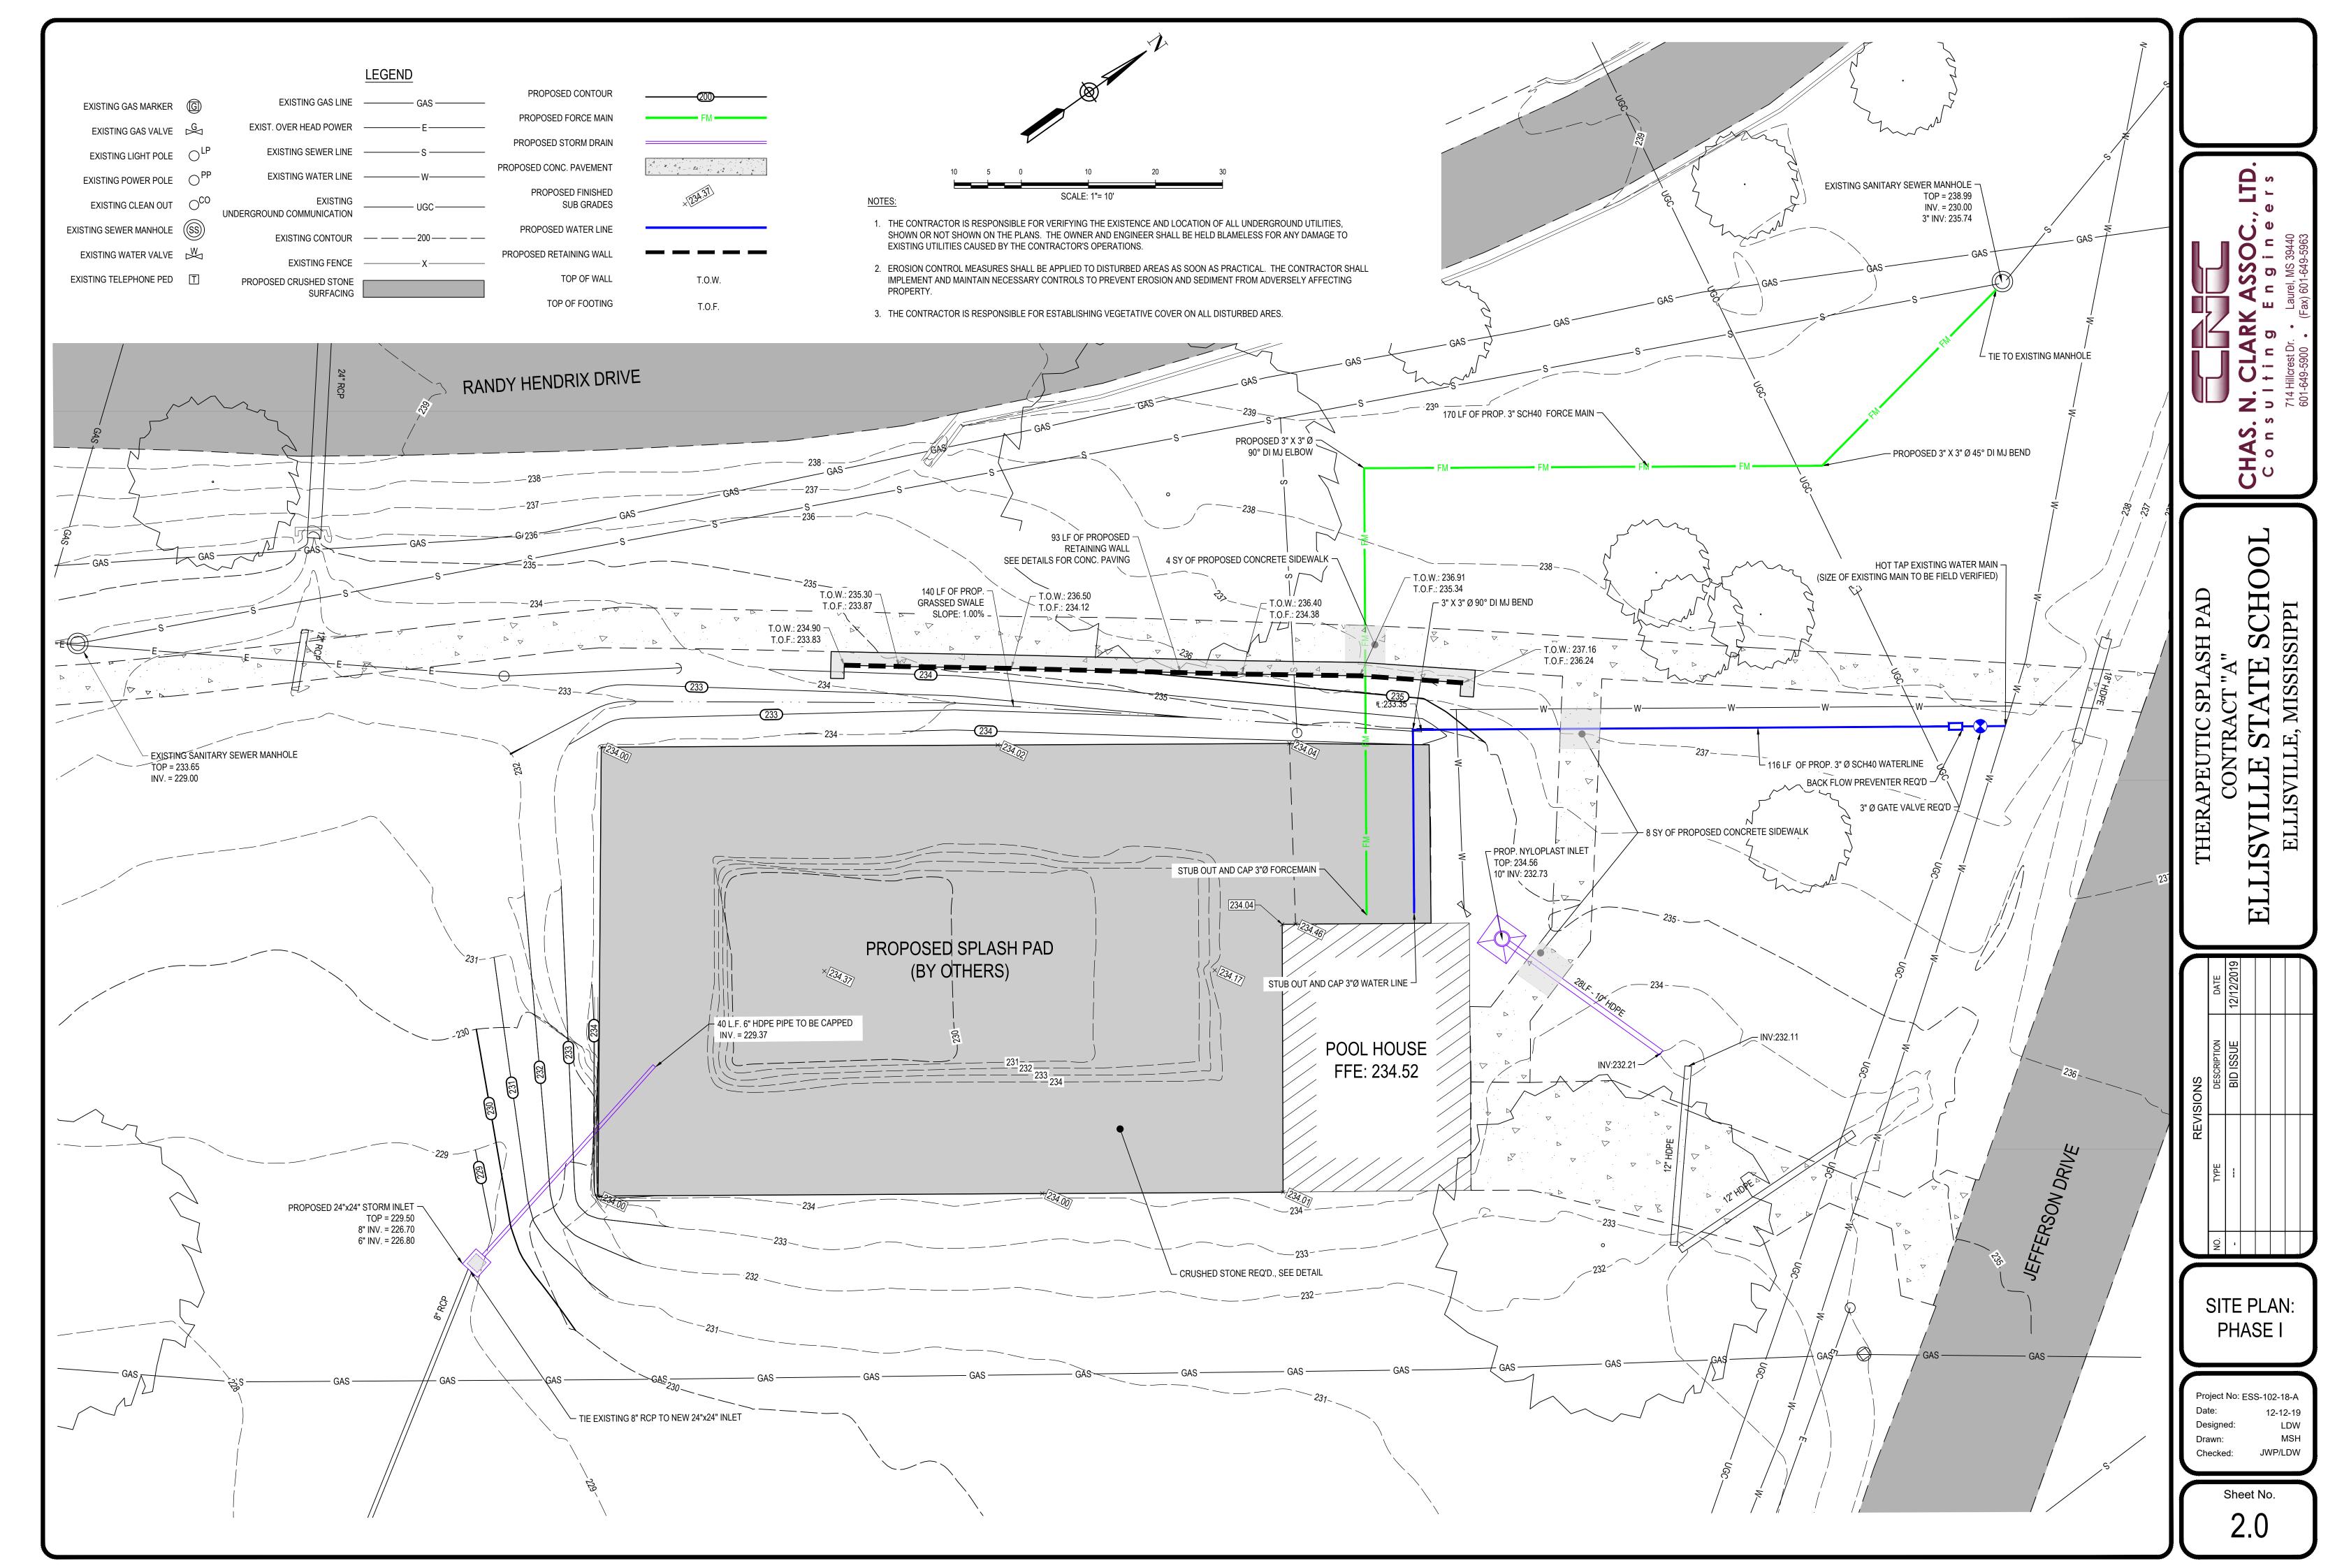


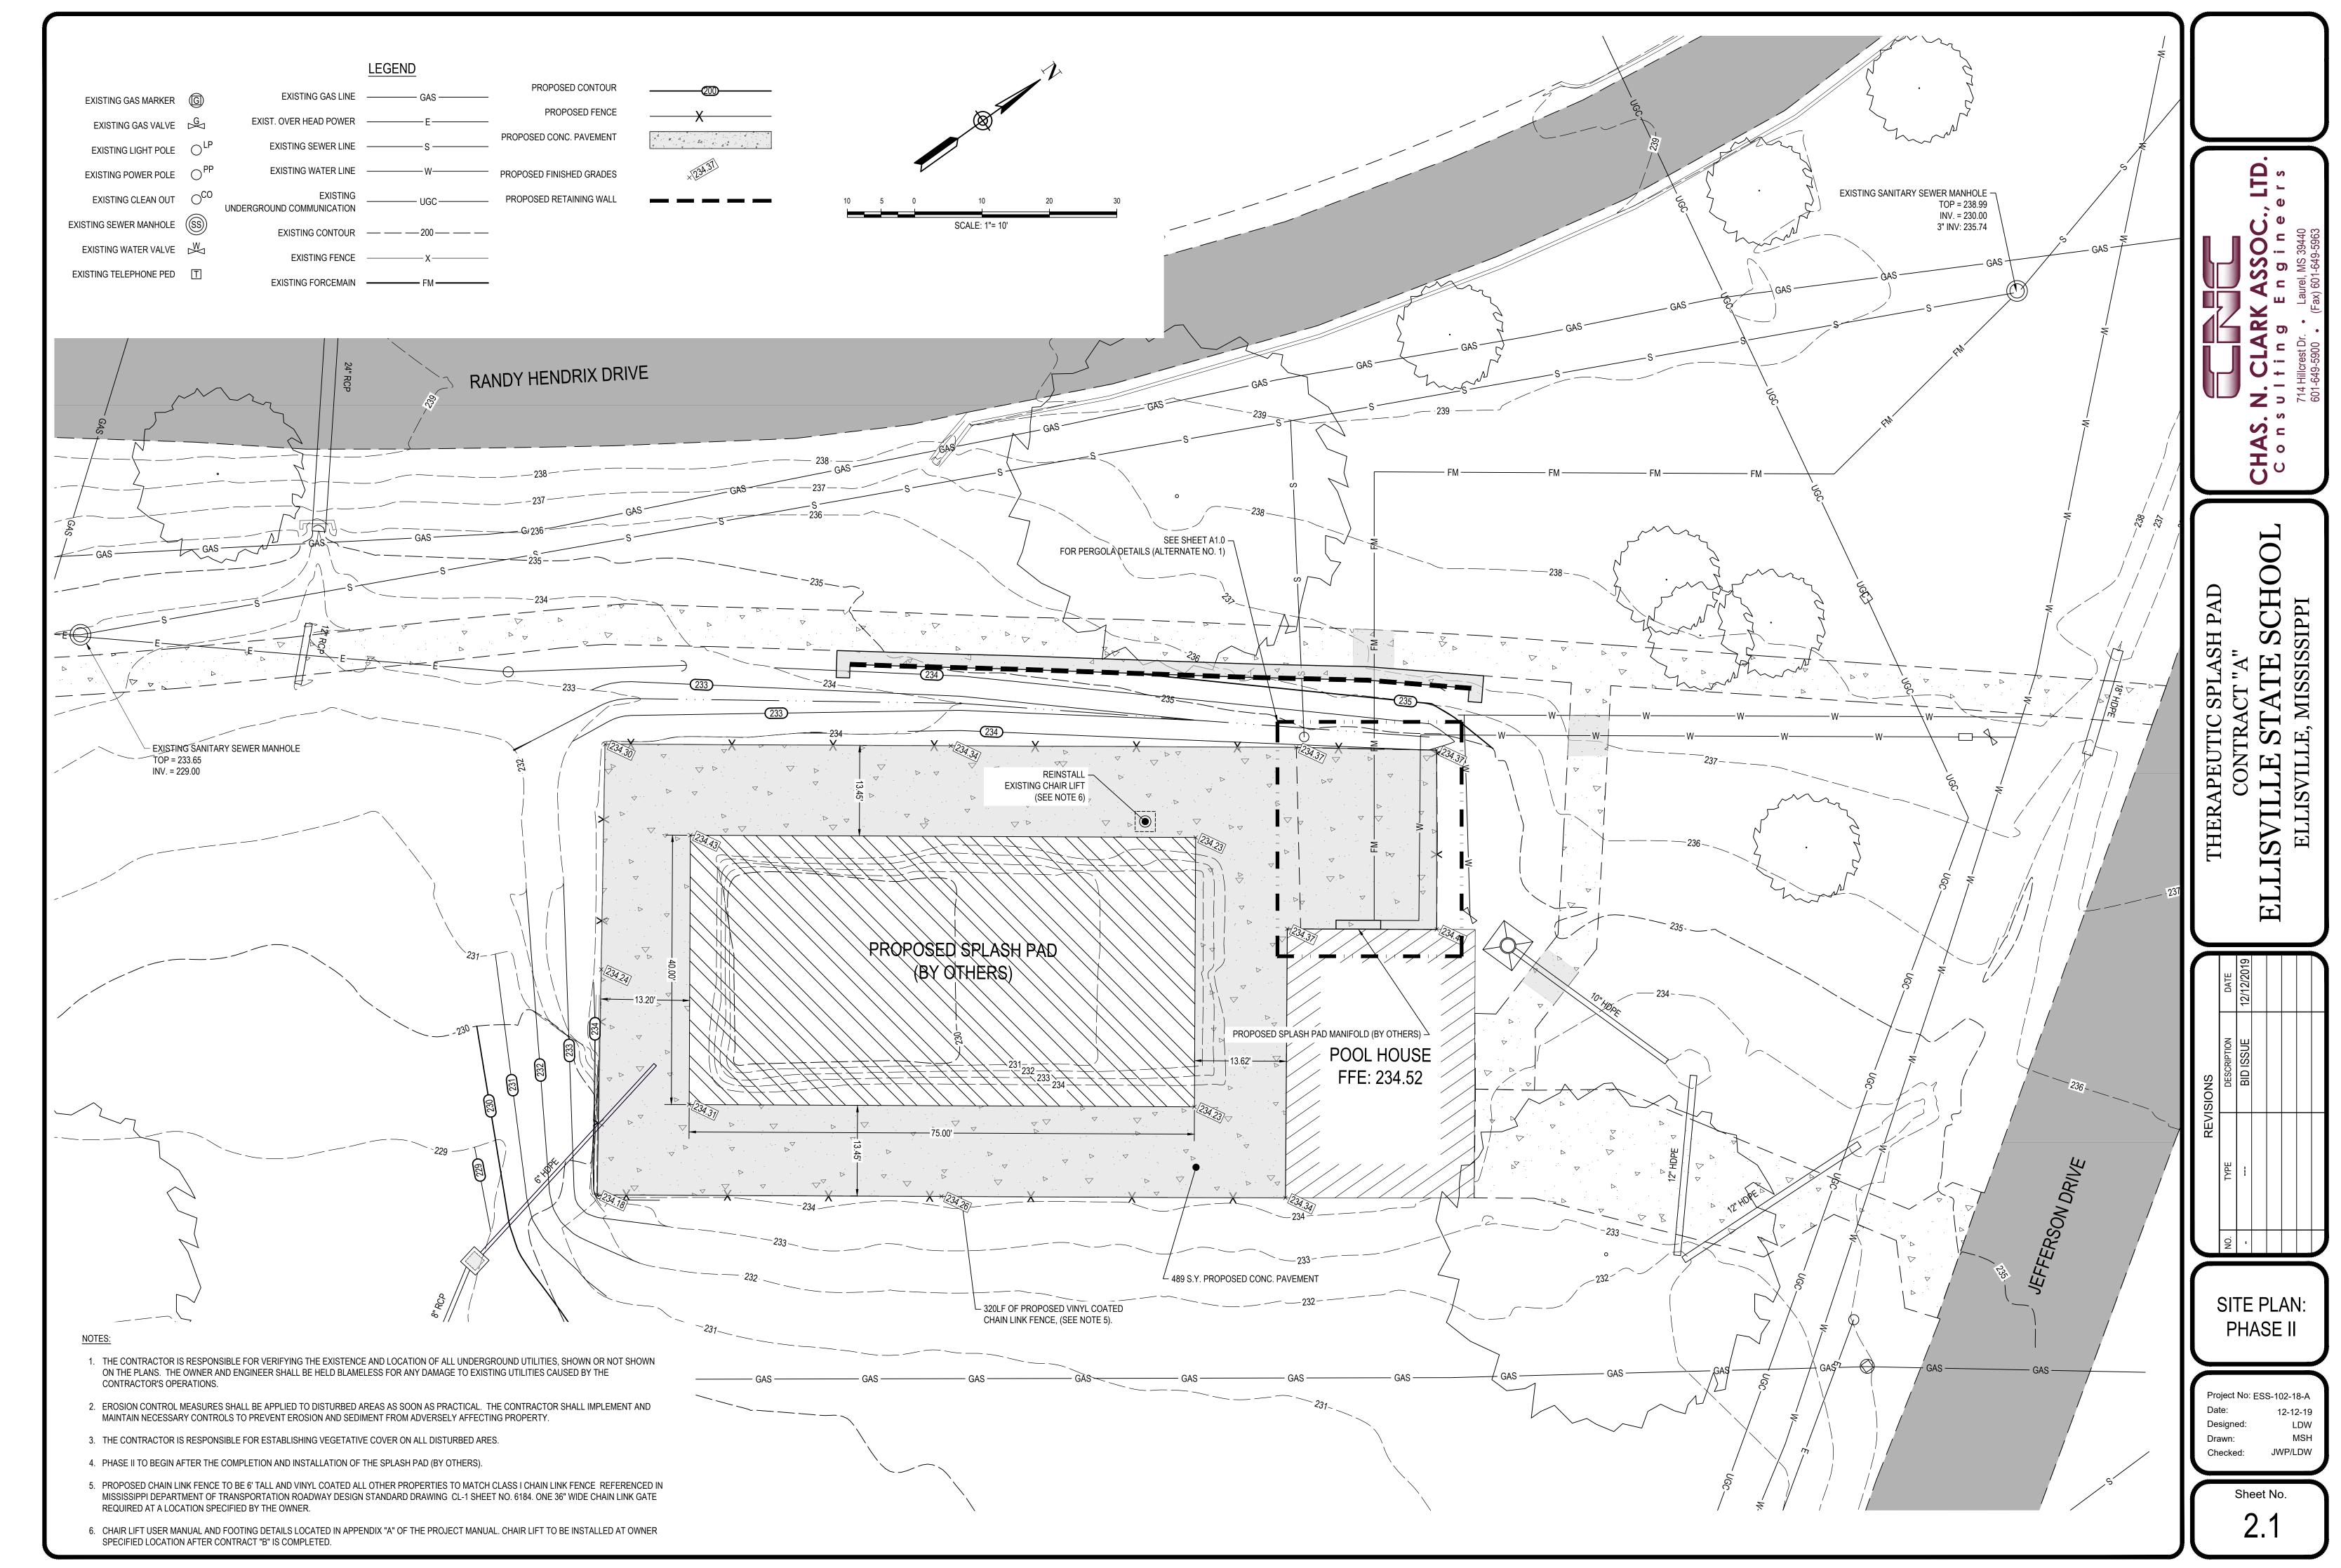

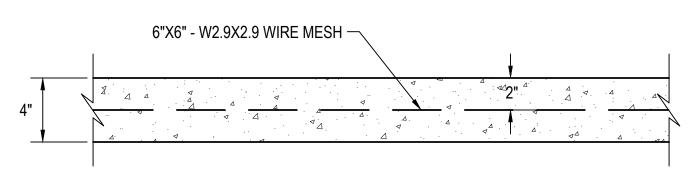


NOTE: EXPANSION MATERIAL REQUIRED WHERE PAVEMENT ABUTS STRUCTURES

CONC. PAVEMENT DETAIL SCALE: N.T.S.

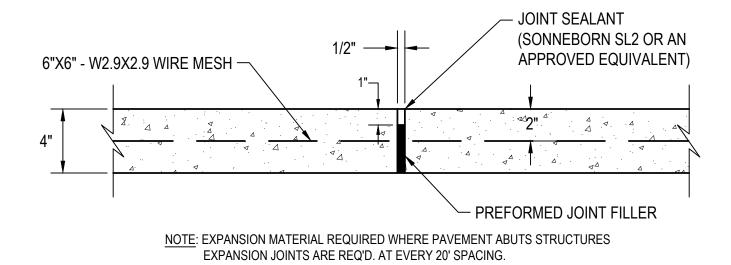


TYPICAL EXPANSION JOINT SCALE: N.T.S.

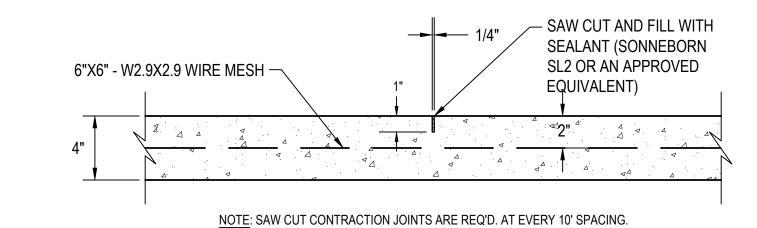

TYPICAL SAW CUT CONTRACTION JOINT

SCALE: N.T.S.

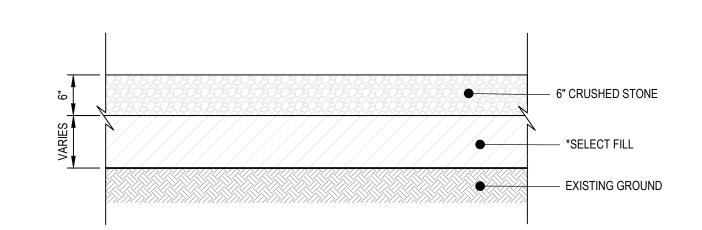


#### CRUSHED AGGREGATE SURFACE DETAIL

\* NOTE:


SCALE: N.T.S.

SELECT FILL TO BE CLASS 7 AS SPECIFIED IN MS STANDARD SPECIFICATIONS FOR STATE AID ROAD AND BRIDGE CONSTRUCTION COMPACTED TO 95% STANDARD PROCTOR IN 8"

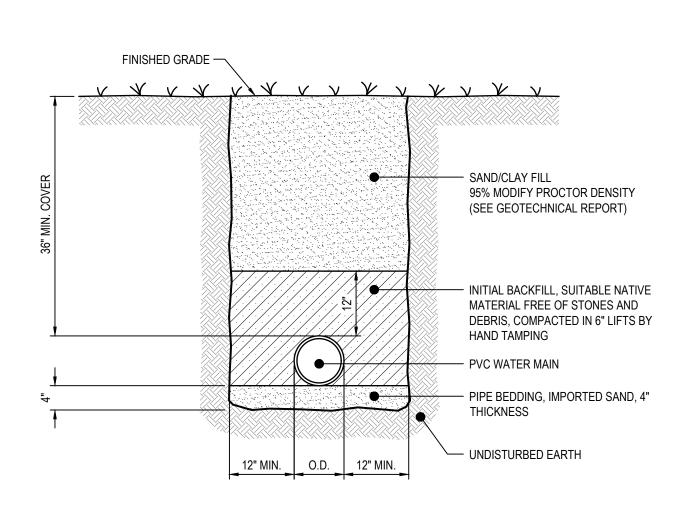


1. NATIVE MATERIAL USED FOR BACKFILL MUST BE FREE OF STONES, DEBRIS, AND ORGANIC MATTER.


PVC PIPE TRENCH DETAIL SCALE: N.T.S.

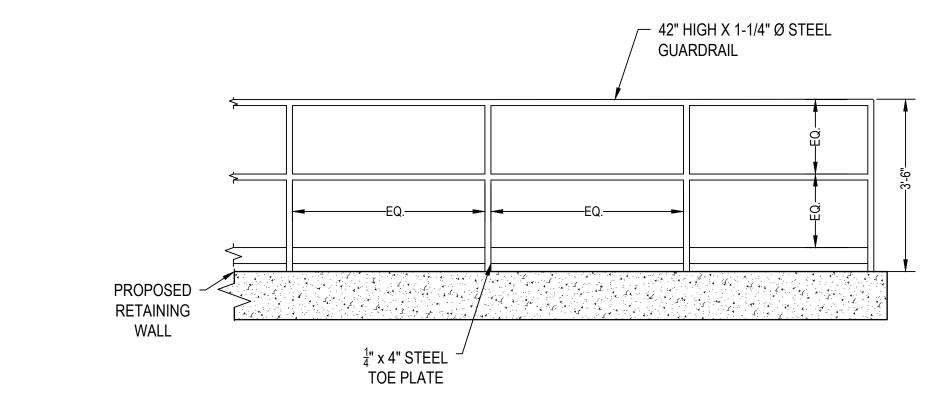


STEEL GUARDRAIL SCALE: N.T.S.

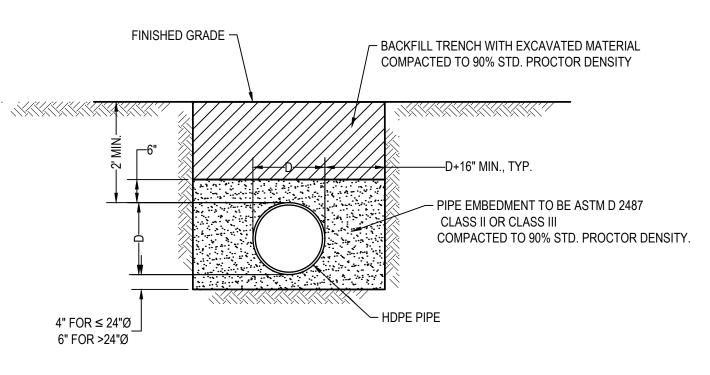

HDPE STORM DRAIN TRENCH DETAIL SCALE: N.T.S.

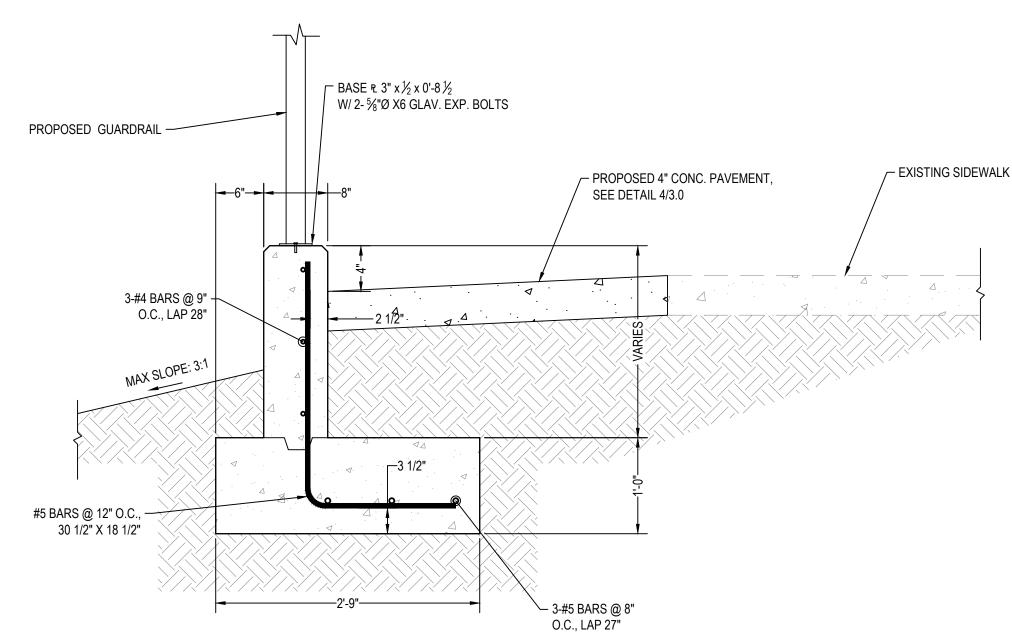

CAST-IN-PLACE RETAINING WALL SCALE: N.T.S.

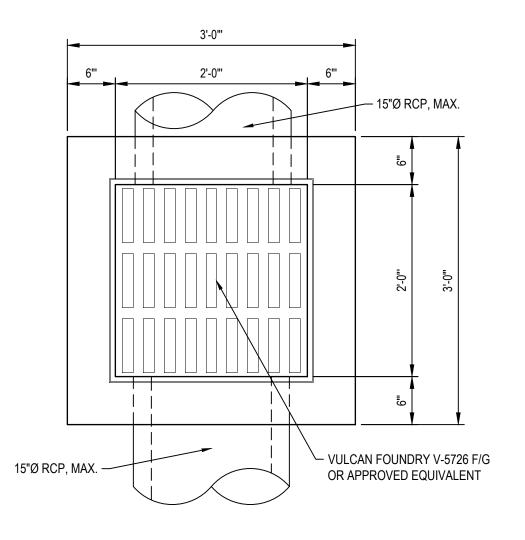

24" x 24" PRECAST INLET PLAN SCALE: N.T.S.

#### INLETS, CATCH BASINS, & JUNCTION BOXES

PRECAST CONCRETE CATCH BASINS SHALL BE EQUIVALENT TO HANSON PIPE & PRODUCTS, INC. MEETING ASTM C-857-92 AND DESIGNED TO MEET AASHTO HS-20-44 LOADING, WITH 6" WALLS, 8" TOP SLABS, AND 8" BASE SLABS EXCEPT THAT 24"x24" DRAINAGE STRUCTURES MAY UTILIZE 6" BASE SLABS. REINFORCING STEEL SHALL MEET ASTM A-615, GRADE 60.

CAST IRON FRAMES AND COVERS FOR CATCH BASINS SHALL BE EQUIVALENT TO MODEL V-5726 F/G BY VULCAN FOUNDRY EXCEPT THAT; -24"x24" INLETS SHALL BE EQUIVALENT TO VULCAN FOUNDRY MODEL V-5766 F/V-5666 G


CAST-IN-PLACE CONCRETE OR MASONRY INLETS AND JUNCTION BOXES MAY BE SUBSTITUTED FOR PRECAST CONCRETE PROVIDED THAT THE CONSTRUCTION COMPLIES WITH MISSISSIPPI STANDARD SPECIFICATIONS FOR STATE AID ROAD AND BRIDGE CONSTRUCTION, JANUARY 2004, AND EXCEPT THAT FRAMES AND COVERS SHALL BE AS SPECIFIED FOR PRECAST INLETS.

**DETAILS** 

Project No: ESS-102-18-A Checked:

Sheet No.

#### NYLOPLAST DRAIN BASIN WITH STANDARD GRATE

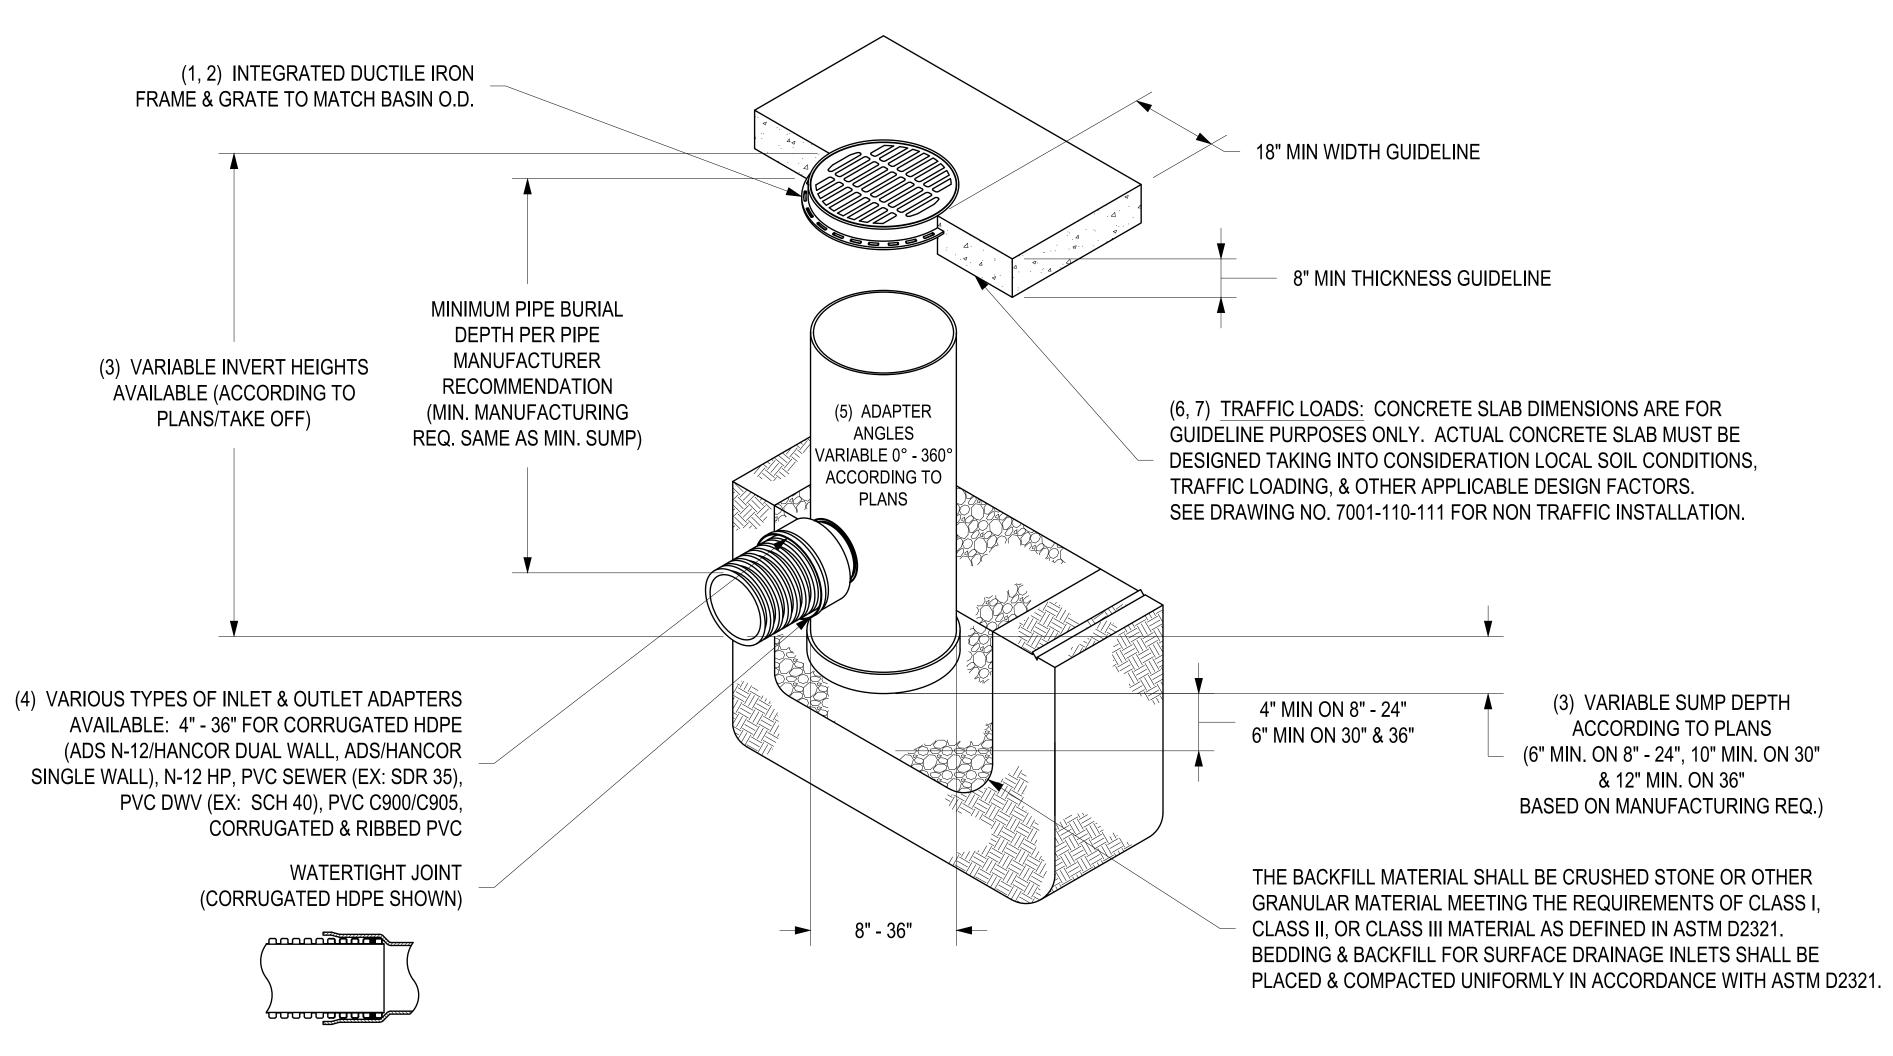

- 1 8" 30" STANDARD GRATES SHALL BE DUCTILE IRON PER ASTM A536 GRADE 70-50-05.
- 2 12" 30" FRAMES SHALL BE DUCTILE IRON PER ASTM A536 GRADE 70-50-05.
   8" & 10" STANDARD GRATES FIT DIRECTLY ONTO DRAIN BASINS WITH THE USE OF A PVC BODY TOP. SEE DRAWING NO. 7001-110-045.
- 3 DRAIN BASIN TO BE CUSTOM MANUFACTURED ACCORDING TO PLAN DETAILS. RISERS ARE NEEDED FOR BASINS OVER 84" DUE TO SHIPPING RESTRICTIONS. SEE DRAWING NO. 7001-110-065.
- 4 DRAINAGE CONNECTION STUB JOINT TIGHTNESS SHALL CONFORM TO ASTM D3212 FOR CORRUGATED HDPE (ADS N-12/HANCOR DUAL WALL), N-12 HP, & PVC SEWER (4" 36").
- 5 ADAPTERS CAN BE MOUNTED ON ANY ANGLE 0° TO 360°. TO DETERMINE MINIMUM ANGLE BETWEEN ADAPTERS SEE DRAWING NO. 7001-110-012.
- 6 12" 30" STANDARD GRATES SHALL MEET H-20 LOAD RATING.
- 7 8" & 10" STANDARD GRATES ARE RATED FOR LIGHT DUTY APPLICATIONS ONLY; NO CONCRETE COLLAR NEEDED FOR LIGHT DUTY RATING.

